Total: 2 pages

Date: 27 November 2025

TPB Ref.: A/YL-TT/754

By Email

Town Planning Board
15/F, North Point Government Offices
333, Java Road
North Point
Hong Kong
(Attn: The Secretary)

Dear Sir,

Temporary Warehouse for Storage of Metal and Timber and Associated Filling of Land for a Period of 3 Years at Lots 2113 (Part), 2114 (Part), 2115 (Part), 2116 (Part) & 2119 (Part) in D.D. 118, Yuen Long, New Territories

We are glad to submit the FSI proposal in support of the captioned application.

We also confirm that the development parameters and the layout of the current application are the same as the last planning permission No. A/YL-TT/575.

In view of that long lead time is required for the application for WWO46 Part V and short term waiver and thereafter the erection of temporary structure and implementation of FSI proposal at the application site, the applicant failed to comply with the condition for the implementation of FSI proposal for the last planning permission No. A/YL-TT/575. The applicant also submitted the drainage proposal but it was found unacceptable to the CE/MN, DSD. The applicant has complied with submission of FSI proposal for the last planning permission.

Should you have any enquiries, please feel free to contact our Mr. Patrick Tsui at at your convenience.

Yours faithfully,

Patrick Tsui

c.c. Tuen Mun and Yuen Long West District Planning Office (Attn: Ms. Momo CHOW) – By Email

## F.S.NOTES:

#### 1. GENERAL

- 1.1 FIRE SERVICE INSTALLATIONS SHALL BE PROVIDED IN ACCORDANCE WITH THE CODES OF PRACTICE FOR MINIMUM FIRE SERVICE INSTALLATIONS AND EQUIPMENT AND INSPECTION, TESTING AND MAINTENANCE OF INSTALLATIONS AND EQUIPMENT 2022 (COP 2022), FSD CIRCULAR LETTERS AND THE HONG KONG WATERWORKS STANDARD REQUIREMENTS.
- 1.2 ALL TUBES AND FITTINGS SHALL BE G.M.S. TO BS1387 MEDIUM GRADE WHERE PIPEWORK UP TO Ø150mm.
- 1.3 ALL TUBES AND FITTINGS SHALL BE DUCTILE IRON TO BS EN545 K12 WHERE PIPEWORK ABOVE Ø150mm.
- 1.4 ALL DRAIN PIPES SHALL BE DISCHARGED TO A CONSPICUOUS POSITION WITHOUT THE POSSIBILITY OF BEING SUBMERGED.
- 1.5 ALL PUDDLE FLANGES SHALL BE MADE OF DUCTILE IRON
- 1.6 THE AGGREGATE AREA OF OPENABLE WINDOWS NOT LESS THAN 6.25% OF THE FLOOR AREA OF THE STRUCTURE
- 1.7 SMOKE EXTRACTION SYSTEM NOT TO BE PROVIDED.

#### 2. HOSE REEL SYSTEM

- 2.1 NEW FIRE HOSE REEL SHALL BE PROVIDED AS INDICATED ON PLAN TO ENSURE THAT EVERY PART OF THE BUILDING CAN BE REACHED BY A LENGTH OF NOT MORE THAN 30m HOSE REEL TUBING.
- 2.2 THE WATER SUPPLY FOR HOSE REEL SYSTEM WILL BE FED FROM A NEW 2m<sup>3</sup> F.S. FIBREGLASS WATER TANK VIA TWO HOSE REEL PUMPS (DUTY/ STANDBY) LOCATED INSIDE FS PUMP ROOM AT EXTERNAL AREA.
- 2.3 HOSE REEL PUMPS SHALL BE STARTED BY ACTUATION OF ANY BREAKGLASS UNIT FITTED ASIDE EACH HOSE REEL SETS
- 2.4 ALL FIRE HOSE REEL OUTLETS SHOULD BE HOUSED IN GLASS FRONTED CABINET SECURED UNDER LOCK & KEY.
- 2.5 ALL FIRE HOSE REEL SHOULD BE PROVIDED WITH FSD APPROVED TYPE INSTRUCTION PLATE & WSD WARNING PLATE
- 2.6 SECONDARY ELECTRICITY SUPPLY DIRECTLY TEE OFF BEFORE CLP'S INCOMING MAIN SWITCH SHALL BE PROVIDED FOR THE FH/HR PUMPS.

#### 3. AUTOMATIC SPRINKLER SYSTEM

- 3.1 NEW AUTOMATIC SPRINKLER SYSTEM SHALL BE PROVIDED AND INSTALLED IN ACCORDANCE WITH LPC RULES FOR AUTOMATIC SPRINKLER INSTALLATIONS INCORPORATING BS EN 12845: 2015 (INCLUDING TECHNICAL BULLETINS, NOTES, COMMENTAR AND RECOMMENDATIONS) AND FSD CIRCULAR LETTER NO. 5/2020. THE CLASSIFICATION OF THE OCCUPANCIES WILL BE ORDINARY HAZARD GROUP III.
- 3.2 ONE NEW 135m3 SPRINKLER WATER TANK WILL BE PROVIDED AS INDICATED ON PLAN. THE TOWN MAIN WATER SUPPLY WILL BE FED FROM SINGLE END.
- 3.3 TWO NEW SPRINKLER PUMPS (DUTY/STANDBY) AND ONE JOCKEY PUMP SHALL BE PROVIDED IN FS PUMP ROOM LOCATED AT EXTERNAL AREA.
- 3.4 NEW SPRINKLER CONTROL VALVE SET AND SPRINKLER INLET SHALL BE PROVIDED AS INDICATED ON PLAN.
- 3.5 A TEST VALVE SHALL BE PROVIDED FOR EACH ZONE OF SPRINKLER PIPE. THIS VALVE SHALL BE AT A CONSPICUOUS POSITION THAT WATER CAN BE DRAINED AWAY EASILY.
- 3.6 ALL SUBSIDIARY STOP VALVES TO BE ELECTRIC MONITORING TYPE.
- 3.8 SECONDARY ELECTRICITY SUPPLY DIRECTLY TEE OFF BEFORE CLP'S INCOMING MAIN SWITCH SHALL BE PROVIDED FOR THE SPRINKLER PUMPS.
- 3.9 THE SPRINKLER SYSTEM DESIGN IS BASED ON THE FOLLOWINGS:

HAZARD CLASS: ORDINARY HAZARD GROUP III TYPE OF STORAGE: POST-PALLET (ST2) STORAGE CATEGORY: CATEGORY MAXIMUM STORAGE HIEGHT: 3.5m

SPRINKLER PROTECTION: CEILING PROTECTION ONLY

### 4. FIRE ALARM SYSTEM

- 4.1 NEW FIRE ALARM SYSTEM SHALL BE PROVIDED IN ACCORDANCE WITH BS 5839-1:202017 AND FSD CIRCULAR LETTERS NO. 6/2021.
- NEW BREAKGLASS UNITS AND FIRE ALARM BELLS SHALL BE PROVIDED AT ALL<sup>3</sup> NEW FIRE HOSE REEL POINTS. THE FIRE ALARM INTALLATION WILL BE INTEGRATED WITH THE HOSE REEL SYSTEM.

### 5. EMERGENCY LIGHTING


5.1 EMERGENCY LIGHTING SHALL BE PROVIDED IN ACCORDANCE WITH 'BS 5266-1:2016 AND BS EN 1838:2013", AND THE FSD CIRCULAR LETTER NO. 4/2021, COVERING ALL AREA. EMERGENCY LIGHTINGS SHALL BE BACKED UP BY BUILT-IN BATTERY AND CAPABLE OF MAINTAINING FUNCTION OF NOT LESS THAN 2 HOURS IN CASE OF POWER FAILURE

# 6. EXIT SIGN


6.1 ALL EXIT SIGNS/DIRECTIONAL EXIT SIGNS SHALL BE PROVIDED IN ACCORDANCE WITH BS 5266-1 :2016 AND FSD CIRCULAR LETTER NO. 5/2008 FOR THE BUILDING. EXIT SIGNS/DIRECTIONAL EXIT SIGNS SHALL BE BACKED UP BY BUILT-IN BATTERY AND CAPABLE OF MAINTAINING FUNCTION OF NOT LESS THAN 2 HOURS IN CASE OF POWER FAILURE.

### 7. PORTABLE APPLIANCES

7.1 PORTABLE HAND OPERATED APPLIANCES SHALL BE PROVIDED AS INDICATED ON PLAN.

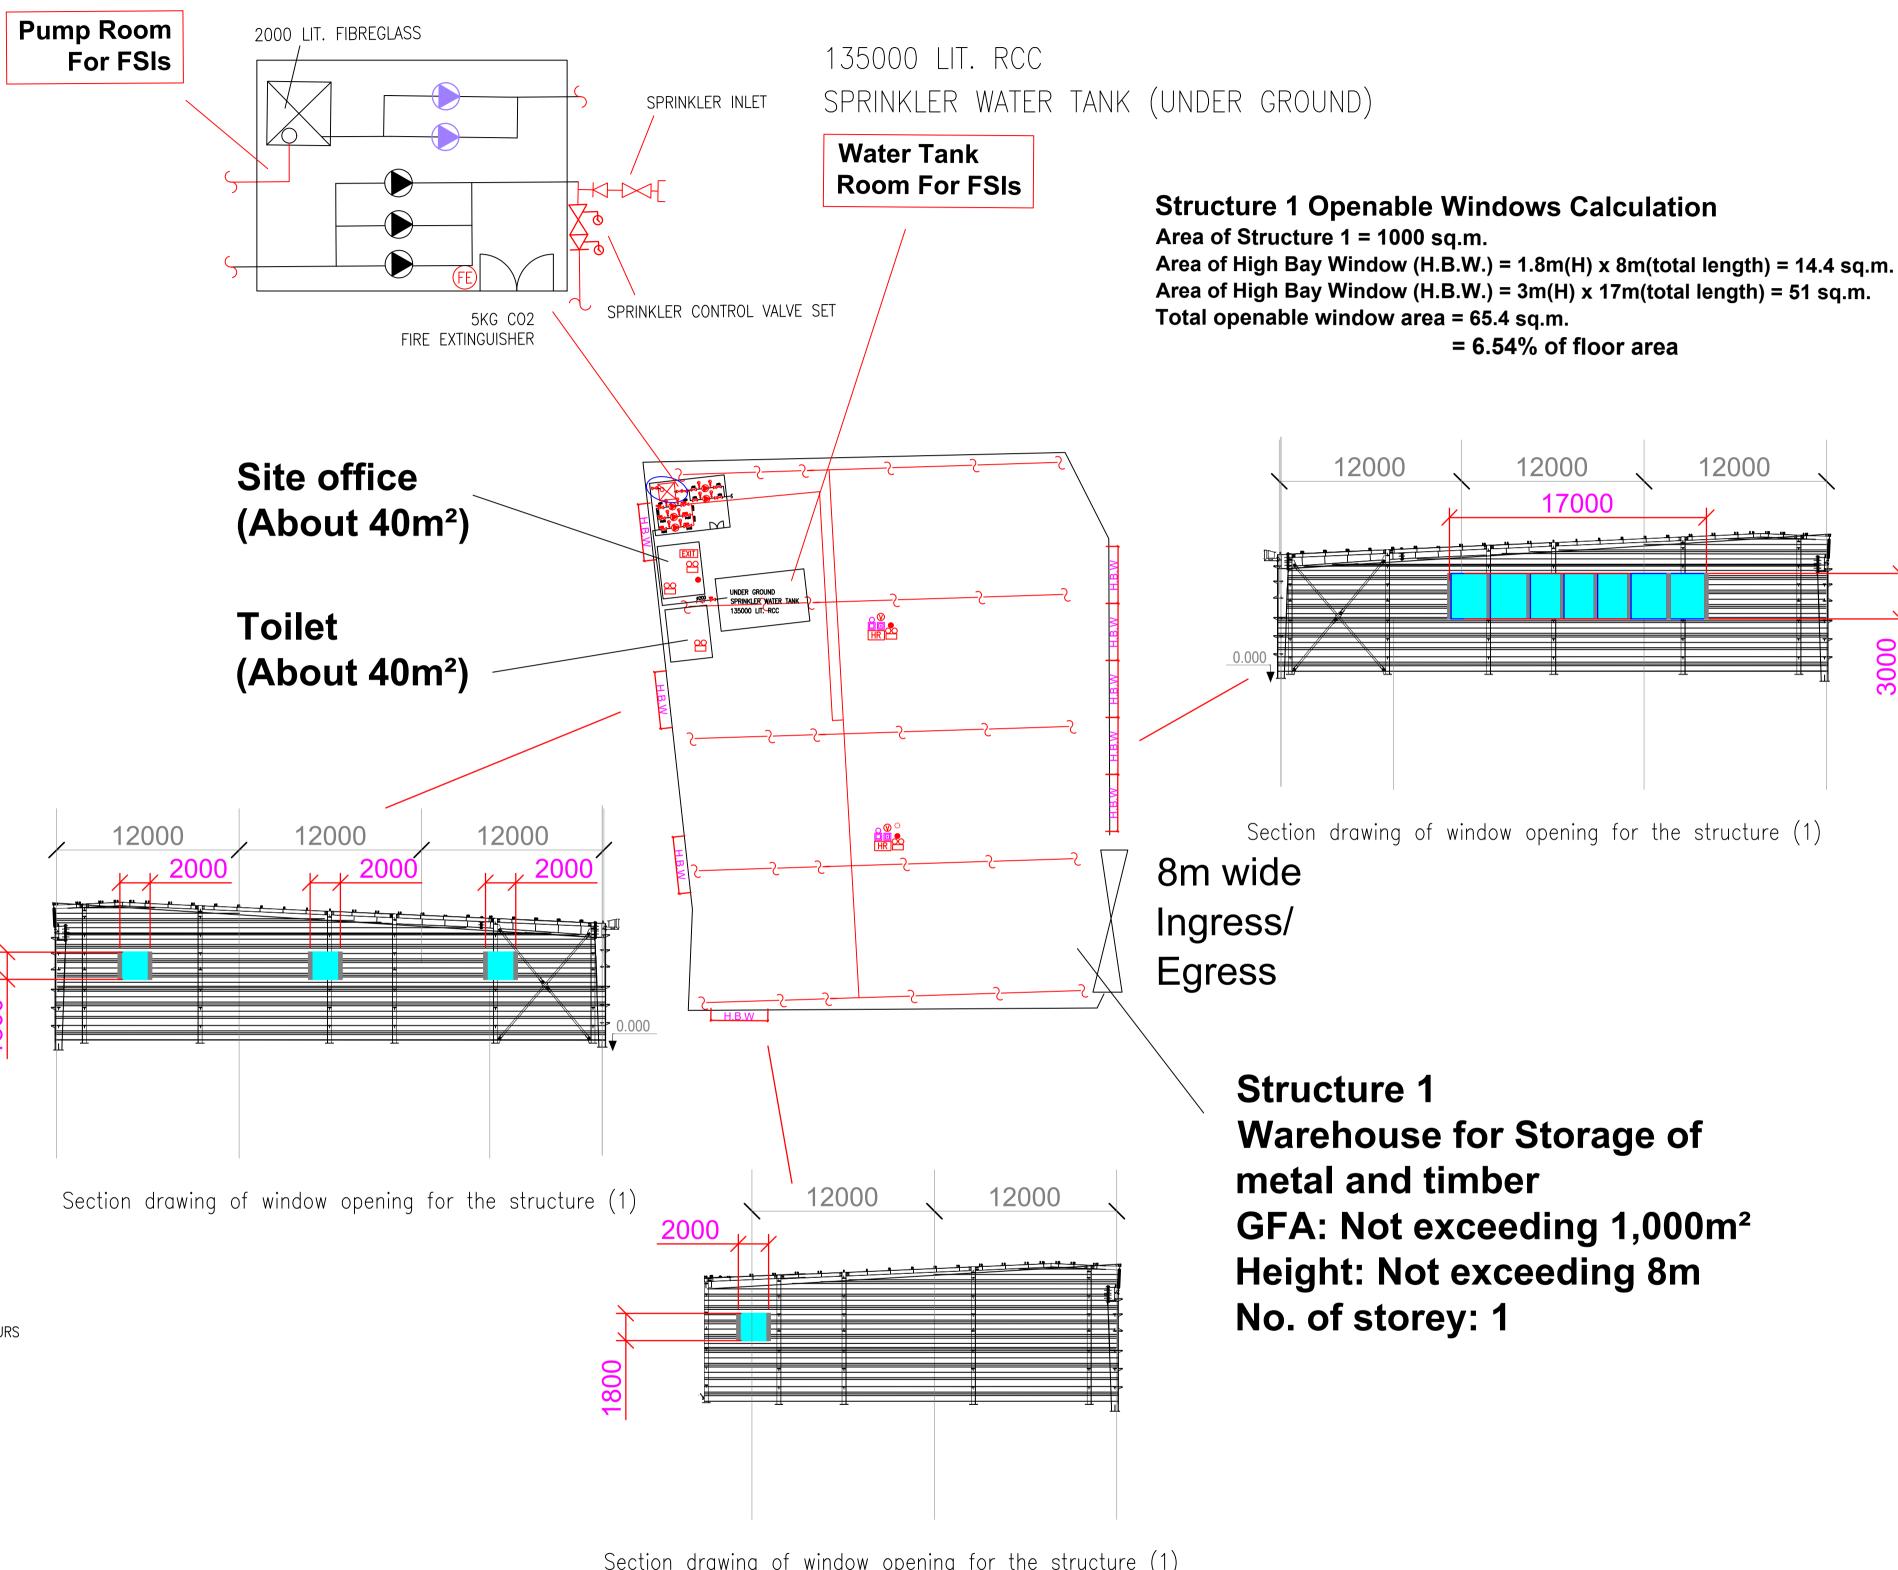

Section drawing of window opening for the structure (1)

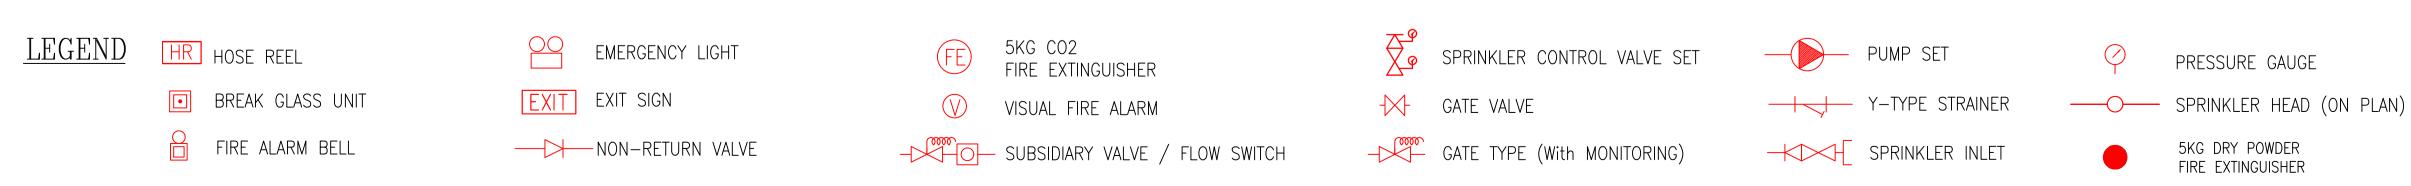

DESCRIPTION

Proposed Temporary Warehouse for Storage of Metal and Timber for a Period of 3 Years and Filling of Land at Lots 2113 (Part), 2114 (Part), 2115 (Part), 2116 (Part) & 2119 (Part) in D.D. 118, Yuen Long, New Territories

DRAWING TITLE: F.S. Notes, Legend, **Fire Service Installation Layout Plan** 

REV

		ARCHITECT :	CONSULTANT :	
 		7		

DATE

FIRE SERVICE CONTRACTOR **Century Fire Service Engineering Co., Ltd.** 

DRAWING NO REV. **FS-01** C.K.NG 25 Oct 2024 SCALE: 1:250 (A1) CHECKED BY B.O.O. Ref. BD APPROVED BY F.S.D. Ref. FP